TO:	COUNCIL ASSESSMENT PANEL
DATE:	24 FEBRUARY 2021
SUBJECT:	COUNCIL ASSESSMENT REPORT
AUTHOR:	DEAN SPASIC
	DEVELOPMENT OFFICER PLANNING
ATTACHMENTS:	1. LOCALITY PLAN
	2. PROPOSED PLANS
	3. STATEMENT OF REPRESENTATION
	4. APPLICANT'S REPLY TO STATEMENT OF REPRESENTATION

DA NO.		110/00940/20
	•	
APPLICANT	:	DESIGNTECH STUDIO
LOCATION	:	17 OLD TAPLEYS HILL ROAD GLENELG NORTH
DEVELOPMENT PLAN	•	CONSOLIDATED 2 JUNE 2016
ZONE AND POLICY AREA	:	RESIDENTIAL CHARACTER ZONE STREETSCAPE CHARACTER (GLENELG
		& GLENELG NORTH) POLICY AREA 14
NATURE OF DEVELOPMENT	:	MERIT
PROPOSAL	:	ALTERATIONS AND TWO STOREY ADDITION WITH BALCONY TO REAR
		OF EXISTING SINGLE STOREY SEMI-DETACHED DWELLING, GROUND
		LEVEL DECK AND CARPORT
EXISTING USE	:	RESIDENTIAL
CATEGORY	:	TWO
REPRESENTATIONS	:	ONE
RECOMMENDATION	:	DEVELOPMENT PLAN CONSENT WITH CONDITIONS

#### 1. Site and Locality

The subject site is located in the Residential Character Zone, to which the immediate locality contains a predominance of older original housing stock and some infill development. Dwellings are predominately single storey however there are numerous examples of two storey development.

#### 2. Proposed Development

The proposal comprises the internal alterations to a single storey semi-detached dwelling, upper storey addition with balcony to rear, and ground level deck and carport.

#### 3. Public Consultation

The proposed development is a merit proposal, and assigned as a Category 2 development for public notification purposes, as per the Procedural Matters Outlined for the Zone (wall on boundary exceeding 2.75 metres in height).

One statement of representation was received, summarised as follows:

Elizabeth Kiely of 15 Old Tapleys Hill Road, Glenelg North:

- Proposed southern wall on boundary exceeds maximum wall height allowance;
- Upper level setback less than minimum required;
- Absence of specification regarding proposed skylight;
- Absence of information regarding construction material on boundary; and
- Wall on boundary will significantly reduce light.

Applicant's reply to statement of representations

- As per the shadow diagrams, the effects of the proposed upper storey are negligible in comparison to the existing level of overshadowing (e.g. the neighbours own shed and verandah already shadows much of their yard);
- The proposed skylight is a Velux vented roof window which will meet Australian Standards;
- The proposed boundary wall will be rendered and painted 'surf mist'

#### 3. Development Assessment

#### HOLDFAST BAY (CITY) DEVELOPMENT PLAN ASSESSMENT TABLE

Two storey dwelling	Development Plan	Proposed	Complies?
Site coverage	Max 50 percent	70%	No (existing coverage 61 percent)
Private open space	Minimum 35 square metres	40 square metres	Yes
Ground level side setback	Wall on boundary up to 3 metres in height over a maximum length of 8 metres	Ground level addition comprises additional wall length of 600mm on northern secondary street boundary extending from the existing boundary wall.	No
		Ground level addition comprises wall length of 2.6 metres and wall height of 3.8 metres to match existing boundary southern wall height	No
Upper level side setback	Where a wall height is up to 6 metres, a	Upper level addition comprises wall height of 6.5 metres setback 2	No

	minimum setback of 2.5 metres Where a wall height exceeds 6 metres, the 2.5 metres plus the additional wall height above 6 metres	metres from the secondary street boundary Upper level addition comprises wall height of 6.5 metres setback 1.6 metres from the southern side boundary	No
Ground level rear setback	4 metres	5 metres	Yes
Upper level rear setback	6 metres	7.6 metres	Yes

### CONSOLIDATED 2 JUNE 2016

GENERAL SECTION – DESIGN AND APPEARANCE	
OBJECTIVES	Assessment
1 Development of a high design standard and appearance that responds to and reinforces positive aspects	Complies
of the local environment and built form.	
PRINCIPLES OF DEVELOPMENT CONTROL	Assessment
1 Buildings should reflect the desired character of the locality while incorporating contemporary designs	Complies
that have regard to the following:	
(a) building height, mass and proportion	
(b) external materials, patterns, colours and decorative elements	
(c) roof form and pitch	
(d) façade articulation and detailing	
(e) verandahs, eaves, parapets and window screens.	
2 Where a building is sited on or close to a side boundary, the side boundary wall should be sited and	Complies
limited in length and height to minimise:	
(a) the visual impact of the building as viewed from adjoining properties	
(b) overshadowing of adjoining properties and allow adequate sun light to neighbouring buildings.	
3 The external walls and roofs of buildings should not incorporate highly reflective materials which will	Complies
result in glare to neighbouring properties or drivers.	
10 The design and location of buildings should enable direct winter sunlight into adjacent dwellings and	Complies
private open space and minimise the overshadowing of:	
(a) windows of habitable rooms	
(b) upper-level private balconies that provide the primary open space area for a dwelling	
(c) solar collectors (such as solar hot water systems and photovoltaic cells).	


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GENERAL SECTION - DESIGN AND APPEARANCE OBJECTIVES (Cont)	Assessment
11 Development should minimise direct overlooking of habitable rooms and private open spaces of	Complies
dwellings through measures such as:	
(a) off-setting the location of balconies and windows of habitable rooms with those of other buildings so	
that views are oblique rather than direct	
(b) building setbacks from boundaries (including building boundary to boundary where appropriate) that	
interrupt views or that provide a spatial separation between balconies or windows of habitable rooms	
(c) screening devices (including fencing, obscure glazing, screens, external ventilation blinds, window hoods	
and shutters) that are integrated into the building design and have minimal negative effect on residents' or	
neighbours' amenity.	
12 Development should ensure that ground-level open space of existing buildings receives direct sunlight	Complies
for a minimum of two hours between 9 am and 3 pm on 21 June to at least the smaller of the following:	•
(a) half of the existing ground-level open space	
(b) 35 square metres of the existing ground-level open space (with at least one of the area's	
dimensions measuring 2.5 metres).	
Development should not increase the overshadowed area by more than 20 per cent in cases where	
overshadowing already exceeds these requirements.	
13 Buildings (other than ancillary buildings or group dwellings) should be designed so that their main	Complies
façade faces the primary street frontage of the land on which they are situated.	,
GENERAL SECTION – RESIDENTIAL DEVELOPMENT	····
OBJECTIVES	Assessment
1 Safe, convenient, pleasant and healthy-living environments that meet the full range of needs and	Complies
preferences of the community.	,
2 A diverse range of dwelling types and sizes available to cater for changing demographics, particularly	Complies
smaller household sizes and supported accommodation.	
4 The revitalisation of residential areas to support the viability of community services and infrastructure.	Complies
PRINCIPLES OF DEVELOPMENT CONTROL	Assessment
1 Residential allotments and sites should maximise solar orientation and have the area and dimensions to	Complies
accommodate:	
(a) the siting and construction of a dwelling and associated ancillary outbuildings	
(b) the provision of landscaping and private open space	
(c) convenient and safe vehicle, pedestrian and cycling access and parking	
(c) convenient and safe vehicle, pedestrian and cycling access and parking	Complies
<ul> <li>(c) convenient and safe vehicle, pedestrian and cycling access and parking</li> <li>(d) water sensitive design systems that enable the storage, treatment and reuse of stormwater.</li> </ul>	Complies
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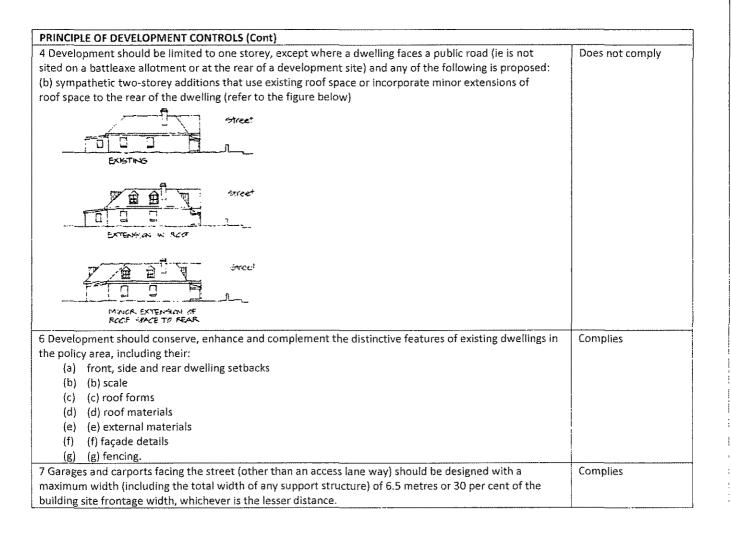
DINICIDIES OF DEVELOBMENT CONTRA	ELOPMENT	Assessment			
PRINCIPLES OF DEVELOPMENT CONTROL (Cont) 12 Development should ensure that ground-level open space of existing buildings receives direct sunlight					
for a minimum of two hours between 9 am and 3 pm on 21 June to at least the smaller of the following:					
(a) half of the existing ground-lev					
(b) 35 square metres of the existing					
dimensions measuring 2.5 me					
	vershadowed area by more than 20 per cent in cases where				
overshadowing already exceeds these n	•				
	hould have a roof form and pitch, building materials and detailing	Complies			
that complement the associated dwellir					
14 Garages and carports facing the stree	et should not dominate the streetscape and should be designed in	Complies			
accordance with the following:					
(a) have a maximum total width o	of garage or carport openings of 6 metres or 50 per cent of the				
dwelling frontage width, whic					
	behind the main face of the associated dwelling				
	nclosed double carport or garage, be setback at least 8 metres from				
	I incorporate one of the following:				
	with a distance of not less than 300 millimetres between them				
	ors with moulded door panels having a maximum width of no more				
than 5 metres					
	at integrate with those of the associated dwelling, or pre-coloured				
treated metal.					
• • • •	r zone, policy area or precinct or Residential High Density Zone,	N/A			
-	t back from the primary road frontage in accordance with the				
following table:					
Setback difference between building					
on adjacent allotments with frontage	fo.				
the same primary street					
Up to 2 metres	The same setback as one of the adjacent buildings, as				
	illustrated below:				
	$a = \epsilon m$ $b = Bm$				
	Wrep billion at 2, setback of new dwelling in a or b				
Greater than 2 metres	At least the average setback of the adjacent buildings.				
20 Dwelling setbacks from side and rear	At least the average setback of the adjacent buildings.	Complies			
20 Dwelling setbacks from side and read building increases to:	boundaries should be progressively increased as the height of the	Complies			
20 Dwelling setbacks from side and read building increases to:	boundaries should be progressively increased as the height of the buildings from adjoining properties	Complies			

RINCIPLES OF DEVELOPMENT CONTROL (Cont)		Assessment		
21 Residential development (other than where locate ear boundaries in accordance with the following par	Does not comply			
Parameter	Value			
Side walls with a height up to (and including) 3 metres at 1 metre any point above the natural ground level				
Side walls with a height exceeding 3 metres and up to (and including) 6 metres at any point above the natural ground	1.5 metres plus an additional 500 millimetres for every metre in height above 4 metres			
Side walls greater than 6 metres at any point above the natural ground level	2.5 metres plus the increase in wall height above 6 metres			
Rear boundary setback for single storey buildings with a wall height 3 metres or less above natural ground level	4 metres			
Rear boundary setback for a building of two or more storeys with a wall height more than 3 metres above natural ground level	6 metres			
<ul> <li>23 Side boundary walls in residential areas should be</li> <li>(a) minimise their visual impact on adjoining provide the state of t</li></ul>	roperties	Complies		
(b) minimise the overshadowing of adjoining p 24 Walls associated with a dwelling located on a side	roperties. boundary should be designed in accordance with the	Does not comply		
ollowing parameters:	boundary should be designed in accordance with the	Does not comply		
<ul> <li>(a) a height not exceeding 3 metres above nature</li> </ul>	ural ground level			
(b) a length not exceeding 8 metres	1			
	ngth of any other relevant walls or structures located			
on that boundary:				
(i) will not result in all such relevant wal	Is and structures exceeding a length equal to 45 per			
cent of the length of the boundary				
(ii) will not be within 3 metres of any oth	ner relevant wall or structure located along the			
boundary, except where the side wal	l is located immediately abutting the wall of an			
existing or simultaneously constructe	d building on the adjoining site and is constructed to			
the same or to a lesser length and he	ight.			
28 Site coverage (the proportion of a site covered by dwelling, garage, carport, verandas and outbuildings balconies) should not exceed the following values: <b>Site Coverage</b>		Does not comply		
28 Site coverage (the proportion of a site covered by gro dwelling, garage, carport, verandas and outbuildings balconies) should not exceed the following values:	ound floor level buildings and structures including but excluding unroofed pergolas and unroofed			
Parameter	Value			
Site with an area less than or equal to 300 square me	etres 60 per cent			
Site with an area greater than 300 square metres	50 per cent	-		
29 Site coverage should ensure sufficient space is pro	vided for:	Complies		
(a) pedestrian and vehicle access and vehicle p				
(b) domestic storage	A CONTRACTOR OF			
(c) outdoor clothes drying				
(d) rainwater tanks				
(e) private open space and landscaping				
(f) convenient storage of household waste and	recycling receptacles.			

GENERAL SECTION -			Assessment		
PRINCIPLES OF DEVELOPMENT CONTROL (Cont)					
		or exclusive use by residents of each dwelling) should be provided	Complies		
		within a residential flat building) and should be sited and designed:	1		
(a) to be accessed directly from the habitable rooms of the dwelling					
(b) to be generally at ground level (other than for residential flat buildings) and to the side or rear of					
	and screened for p				
	<ul> <li>(c) to take advantage of, but not adversely affect, natural features of the site</li> <li>(d) to minimise overlooking from adjacent buildings</li> </ul>				
25 2					
	10.0 C	edroom windows on adjoining sites			
		provide for comfortable year-round use			
		during winter by the associated dwelling or adjacent development			
(h) to be shad		liter insurante that many avian from the file industry or athen to a			
	sector and the sector and	lity impacts that may arise from traffic, industry or other business			
	vithin the locality	and to be functional taking into consideration the location of the			
		ape to be functional, taking into consideration the location of the			
		and gradient of the site.	Complies		
32 Dwellings and res to the requirements		igs at ground level should include private open space that conforms	Complies		
States of the second	Constant of the second second second				
Site area of dwelling	Minimum area of private open	Provisions			
	space				
250 square metres or	20 per cent of site	Balconies, roof patios, decks and the like, can comprise			
greater	area	part of this area provided the area of each is 10 square			
		metres or greater.			
		One part of the space should be directly accessible from a			
		kitchen, lounge room, dining room or living room (excluding a bedroom) and have an area equal to or greater than 10	1.		
		per cent of the site area with a minimum dimension of 5			
		metres and a maximum gradient of 1-in-10.			
33 Private open spac	e should not includ	de driveways, front yards (except where it is a group dwelling that	Complies		
	public road and th	e private open space is screened from adjacent dwellings), effluent			
has no frontage to a		· · · · · · · · · · · · · · · · · · ·			
	ish bin storage, site	es for rainwater tanks and other utility areas and common areas	1		
drainage areas, rubb					
drainage areas, rubb such as parking areas	and communal of		Complies		
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DESIRED CHARACTER (Cont)	
The majority of dwellings were constructed between the 1880s and 1920s, are predominantly single storey	
in height and built on allotments that range in area from 200 to 600 square metres. These dwellings	
typically comprise semi-detached, small detached and row dwelling forms with small setbacks from the	
street. Setbacks typically range between 3 and 6 metres (and less from secondary frontages for corner	
allotments). These setbacks create small front yards that, when added to the low (less than 1 metre in	
height) and simple fencing forms such as timber picket, paling, woven wire on timber frames or rolled steel	
fencing, and typical cottage gardens, add to the intimate scale of the established streetscape.	
Relative to other residential areas, development in the policy area will be slow and progressive, resulting in	
the existing predominant character being maintained, albeit in a modified form, with increasing numbers	
of new dwellings as older dwellings are replaced with contemporary, sympathetically designed buildings	
and housing forms that respond to new lifestyle choices. Development will respect and enhance the special	
character qualities of the policy area, without necessarily replicating existing older building forms to	
achieve this outcome.	
Development will reinforce the character of the policy area established by the existing mix of	
predominantly small-scale traditional dwelling types, and complement those dwelling types through	
appropriate mass, composition, architectural detailing, materials and colours. New buildings will	
incorporate pitched roof forms together with veranda and portico elements. Where row dwellings are a	
dominant feature in the streetscape, new buildings may also incorporate parapets to front facades.	
Development will be single storey in scale and exhibit typical residential design forms that are	
complementary to the predominant established character of the policy area. There may be some	
circumstances where site dimensions enable two-storey development, primarily for detached dwellings,	
provided this development contributes to the streetscape through other key characteristics (eg	
development footprint, height, massing and architectural detail) that will match or relate closely to those	
of the established detached dwellings in the locality.	
Front setbacks will be consistent with those of adjacent sites, creating a uniform street elevation defined	
by landscaped front yards that contribute to the established streetscape character. Development will	
utilise visible hip or gable roof forms, and materials and finishes that respond to the character of the	
immediate locality, including brick, stone and rendered finish providing visual interest to facades.	
Development will also incorporate architectural design and detailing that responds to localised character	
by way of fenestration, doorways, windows, eaves and roof forms, utilising materials that are generally	
dark in colour to limit glare and reflection.	
Garaging will be located clearly behind the alignment of the adjacent domestic portion of the dwelling with	
front and side setbacks that reflect predominant setbacks of sites in the locality. Driveway design will also	
be subsidiary to the domestic built form with the use of a single vehicle crossover point for each dwelling	
and landscaping that provides breaks to expanses of hardstand surfaces.	
PRINCIPLE OF DEVELOPMENT CONTROLS	ASSESSMENT
1 The following forms of development are envisaged in the policy area:	Complies
<ul> <li>detached dwelling</li> </ul>	
<ul> <li>domestic outbuilding in association with a dwelling</li> </ul>	
domestic structure	
dwelling addition	
row dwelling	
• semi detached dwelling.	
3 Development should not be undertaken unless it is consistent with the desired character for the policy	Complies
area.	



#### 5. Summary of Assessment
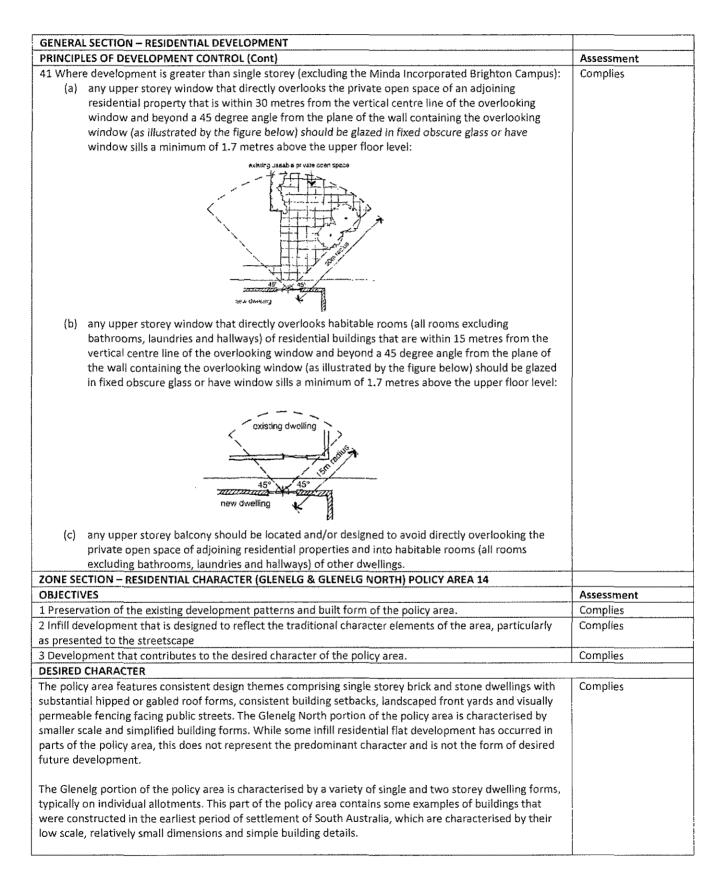
#### **Built Form**

The Zone anticipates single storey built form, as per the examples provided in the Zone Principle of Development Control 4. The proposed upper level addition reflects a more conventional two storey building, with external walls up to 6.5 metres in height.

The proposed design is considered to complement the scale of the existing building, being set behind the front part of the building, comprising a pitched roof, with metal walling and roofing materials, which will blend-in with the existing steel roof.

#### Side Boundary Setbacks and Boundary Walls

The proposal comprises ground level walls on both the northern secondary street boundary and southern side boundary, which is a continuation of the existing boundary to boundary development of the original dwelling. The northern secondary street boundary wall comprises a length of 600mm and is the same height and materials as the existing boundary wall, and is considered to be visually appropriate.

The southern boundary wall comprises a height of 3.8 metres (matching the existing boundary wall) over a length of 2.5 metres. The Development Plan anticipates a maximum wall height of 3 metres over a length of 8 metres, therefore, on balance, a 3.8 metre high wall over a length of only 2.5 metres results in a lesser impact in comparison to the Development Plan's 'as-of-right' boundary allowances.

The upper level wall has a height of 6.5 metres, setback 2 metres from the northern secondary street boundary. The Development Plan anticipates a minimum setback of 4 metres from the secondary street. The northern elevation is considered to reflect a high architectural standard to which it is considered to provide positive visual interest to the streetscape. As such, the 2 metre setback variance is not considered to result in an adverse visual impact on the streetscape so as to warrant a refusal.

The upper level wall has a height of 6.5 metres, setback 1.6 metres from the southern side boundary. The Development Plan anticipates a maximum wall height of 6 metres setback 2.5 metres from the side boundary. When considering visual and overshadowing impacts, the southern elevation reflects a good architectural standard. In terms of solar access, the southern adjacent property has an existing shed which is located adjacent to the common boundary, as well as a small rear verandah, which covers approximately half of the rear yard and contributes to overshadowing into the yard and rear section of the dwelling.

The upper level addition would contribute to further overshadowing, however on balance, in comparison to the shadowing associated with the existing shed and verandah, the additional impacts are considered negligible.

#### **Visual Privacy**

Visual privacy is addressed by way of the absence of any upper level windows on the southern elevation, and the rear balcony comprising 1.7 metre high screening in order to prevent downward views into neighbouring properties

#### 6. Conclusion


The proposed development fails to satisfy the Development Plan provisions with respect to built form (not single storey) and side boundary wall height and setbacks. However, as discussed, the proposal reflects a high architectural standard in which the shortfalls are considered negligible in that the built form is complementary to the buildings in the immediate and surrounding locality, and the building wall heights and associated setbacks are such that they do not result in any significant adverse planning impacts, in addition to any existing impacts, such as overshadowing.

#### 7. RECOMMENDATION

- 1. The proposed development is NOT seriously at variance with the policies in the Development Plan.
- 2. Following a detailed assessment of the proposal against the provisions of the Holdfast Bay (City) Development Plan, the Council Assessment Panel resolves to <u>grant</u> <u>Development Plan Consent</u> to Development Application 110/00940/20 comprising the construction of alterations and two storey addition with balcony to rear of existing single storey semi-detached dwelling, ground level deck and carport at 17 Old Tapleys Hill Road, Glenelg North.


#### PLANNING CONDITIONS


- 1. The proposal shall be implemented as shown on the plans prepared by Designtech Studio, Sheets 1 to 7 unless varied by any subsequent conditions imposed herein.
- 2. The upstairs balconies shall have fixed screens up to 1.7 metres in height above the balcony floor level so as to prevent views into adjacent residential properties.
- 3. Boundary walls shall be finished in materials and colours that match the existing walls.

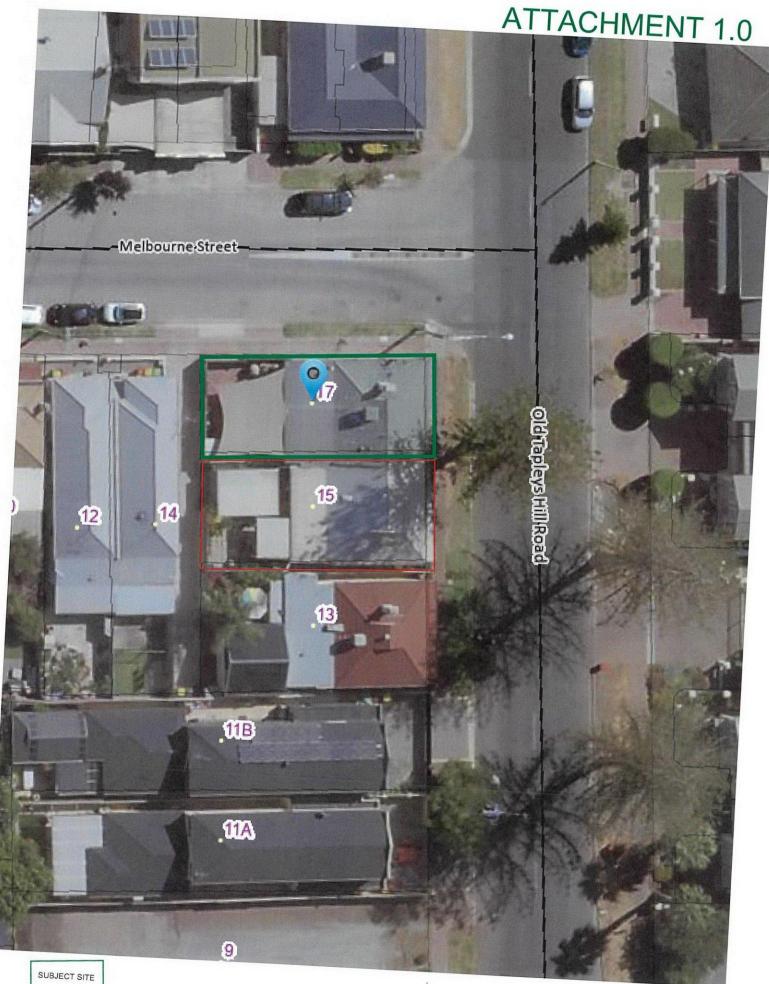



REPRESENTOR Document Set ID: 4063142 Version: 2, Version Date: 04/02/2021 17 OLD TAPLEYS HILL ROAD GLENELG NORTH 110/00940/20


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CLIENT APPROVED NAME: SIGNED: DATE:/	DR	ROPOSED 3D	VIEW		
AGAINST ANY INFRINGEMENT IN WHOLE OR BEEN		DESIGNTECH	DATE: 29/10/20 SHEET: 1 OF 7 ON A3 SCALE: N/A 5041 DRAWN: R.M	PROPOSAL: SITE:	L. & K. FULLER ALTERATIONS & ADDITION No 17 OLD TAPLEYS HILL RD;

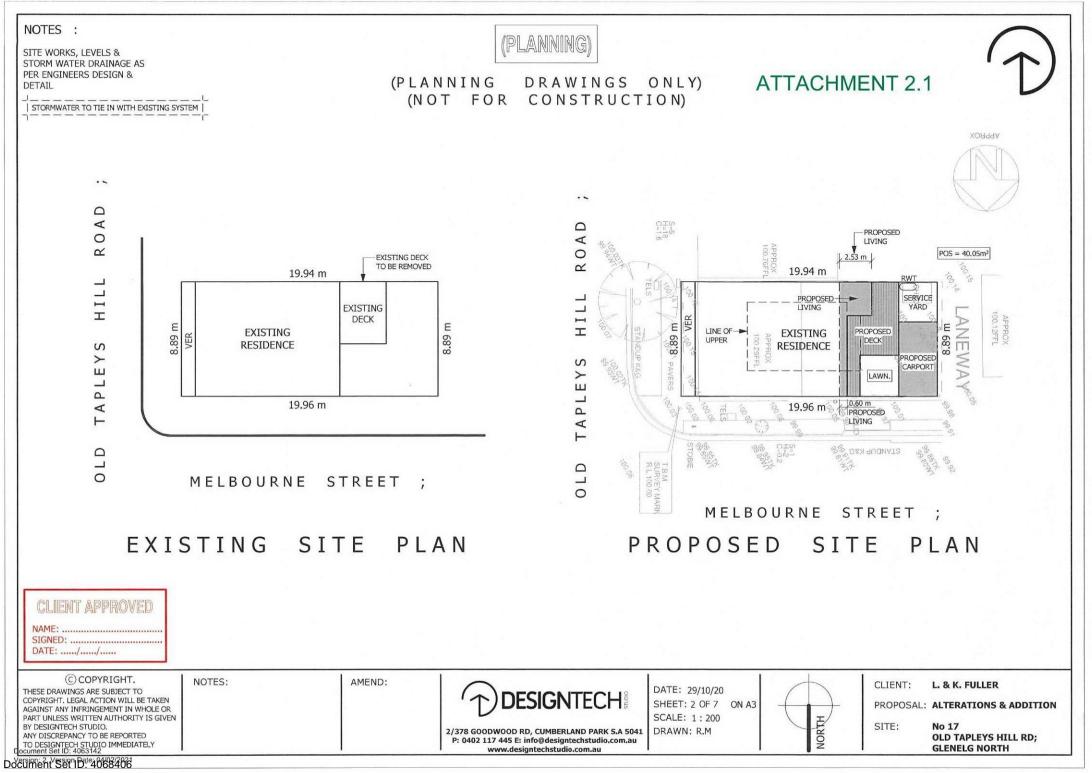


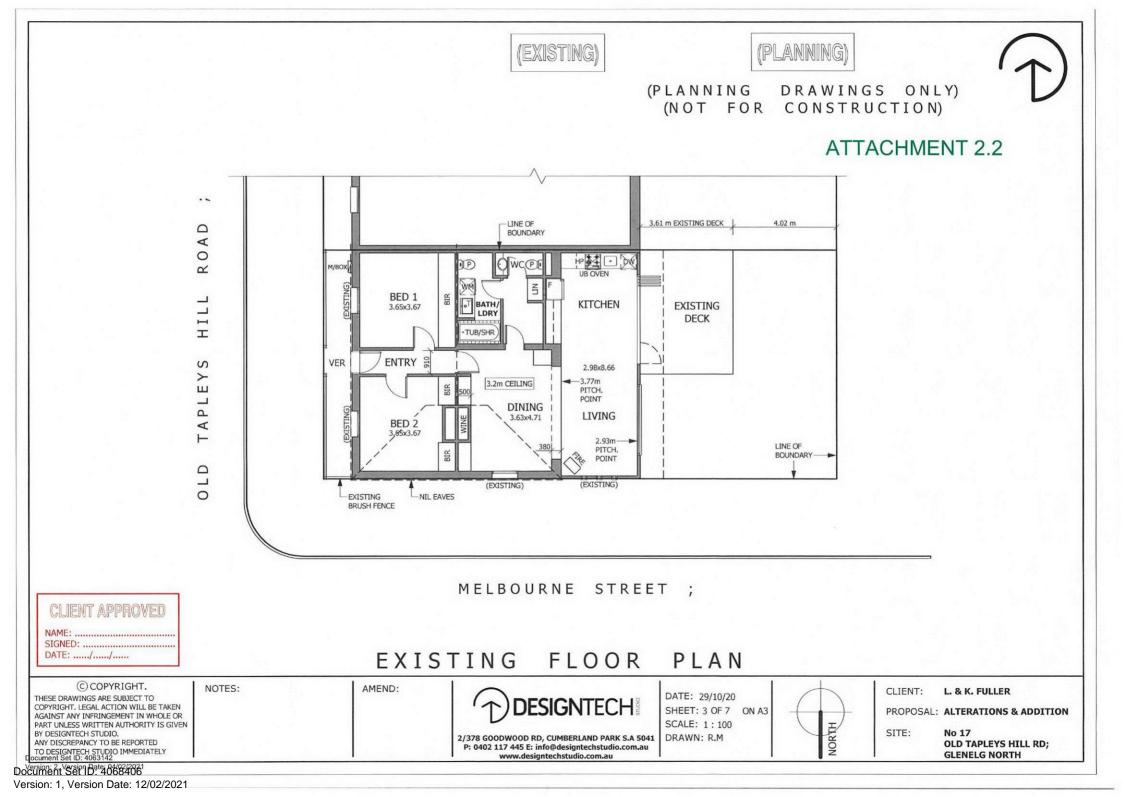


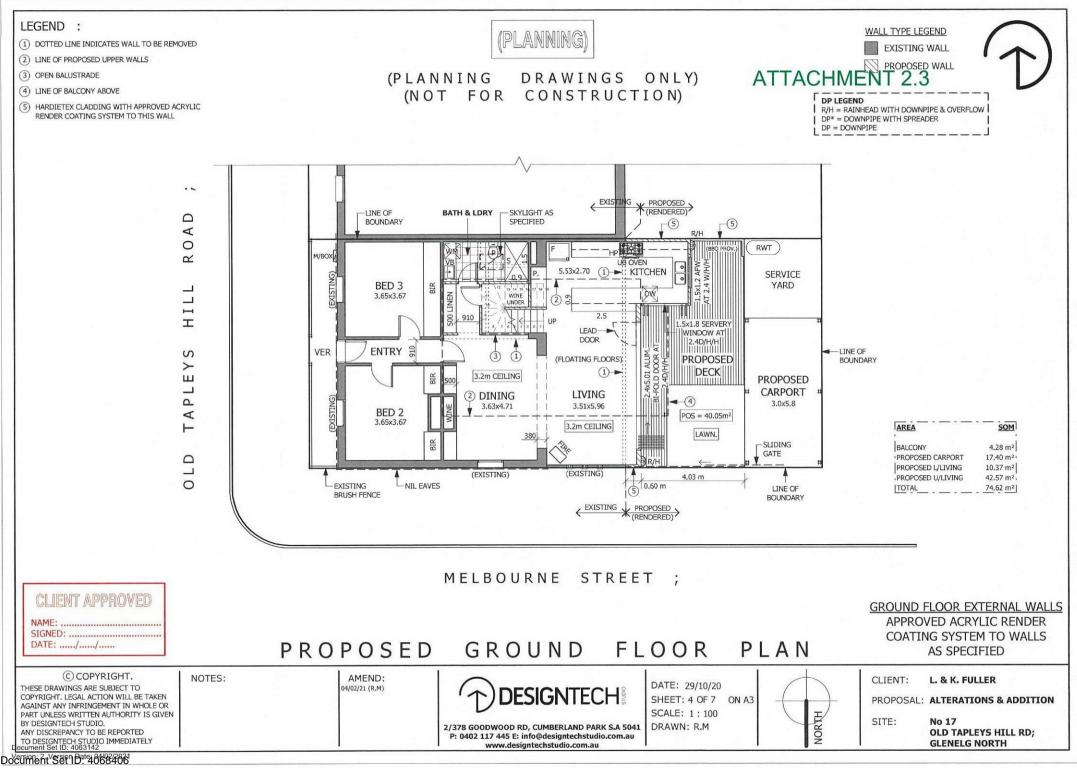

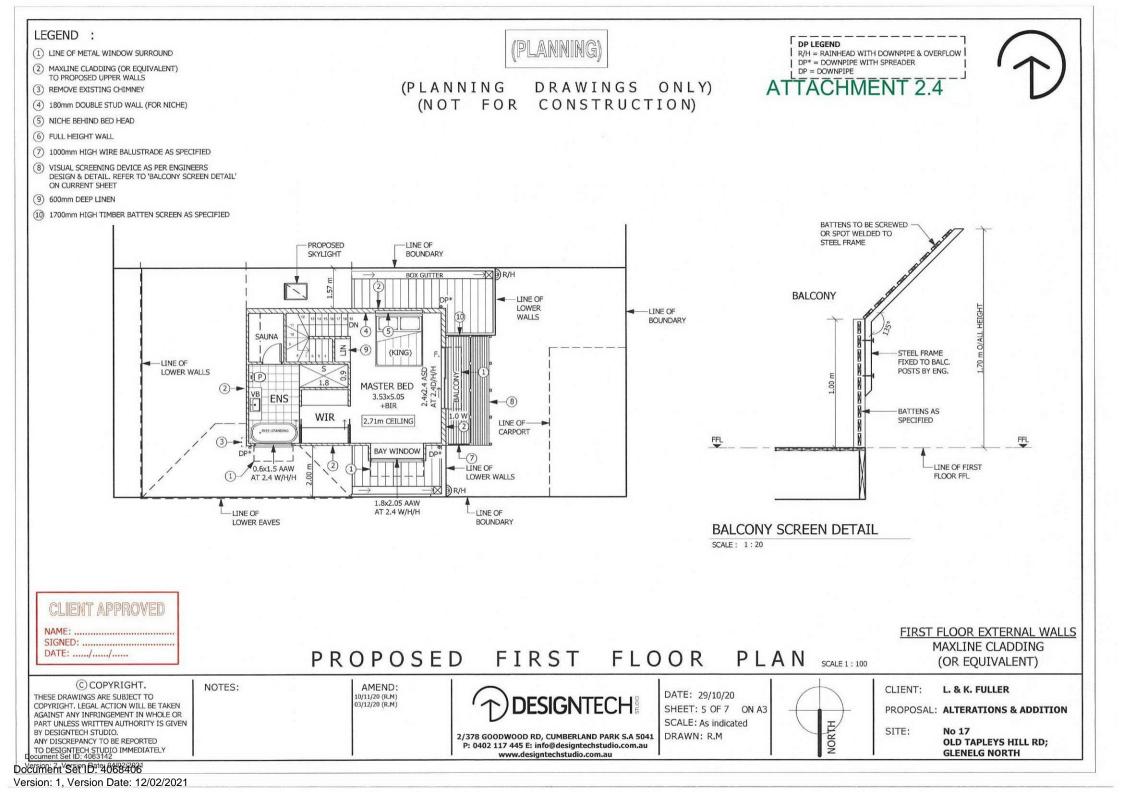

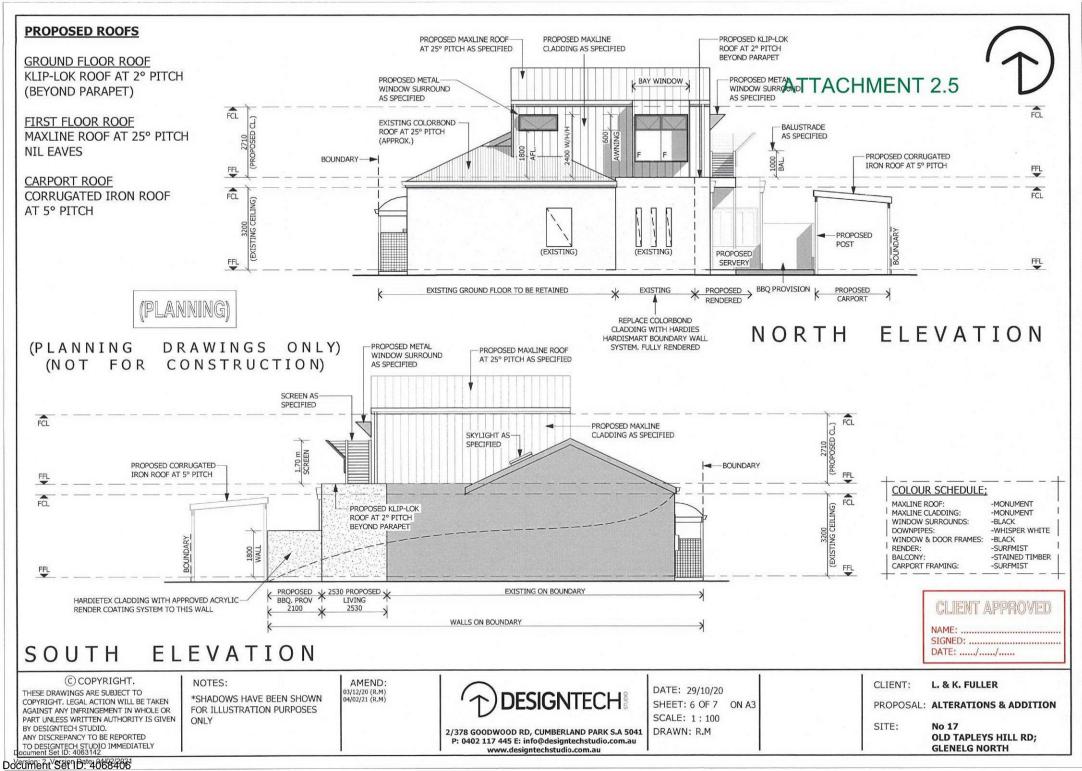

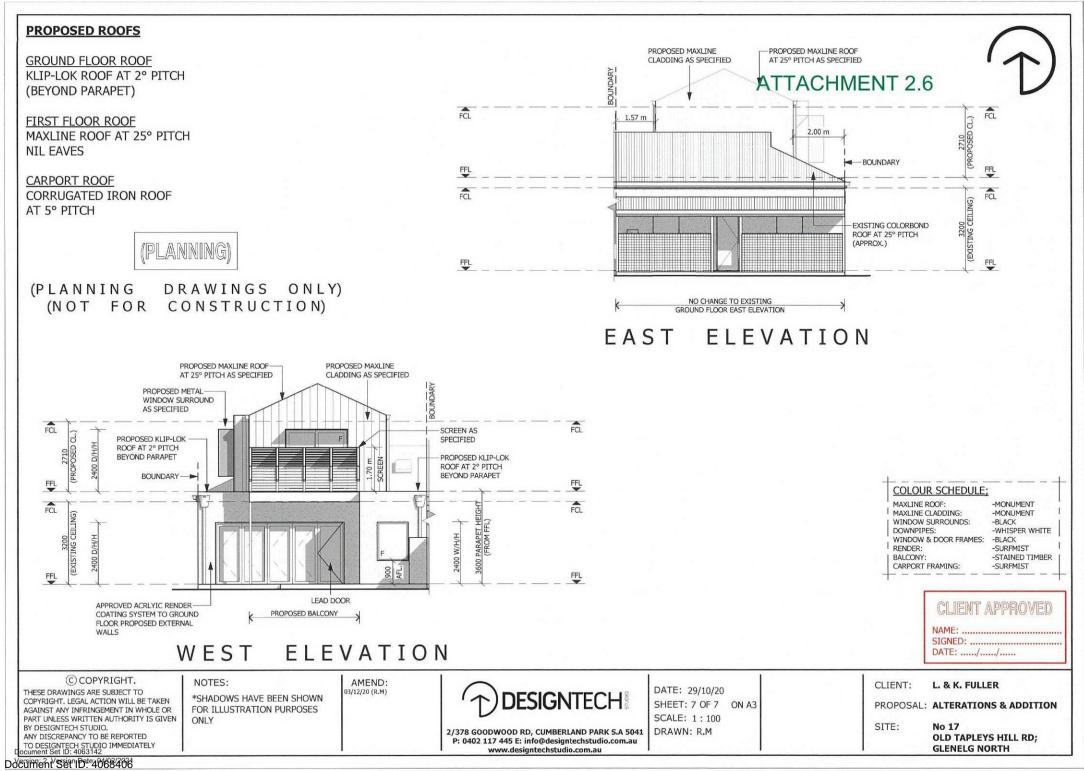

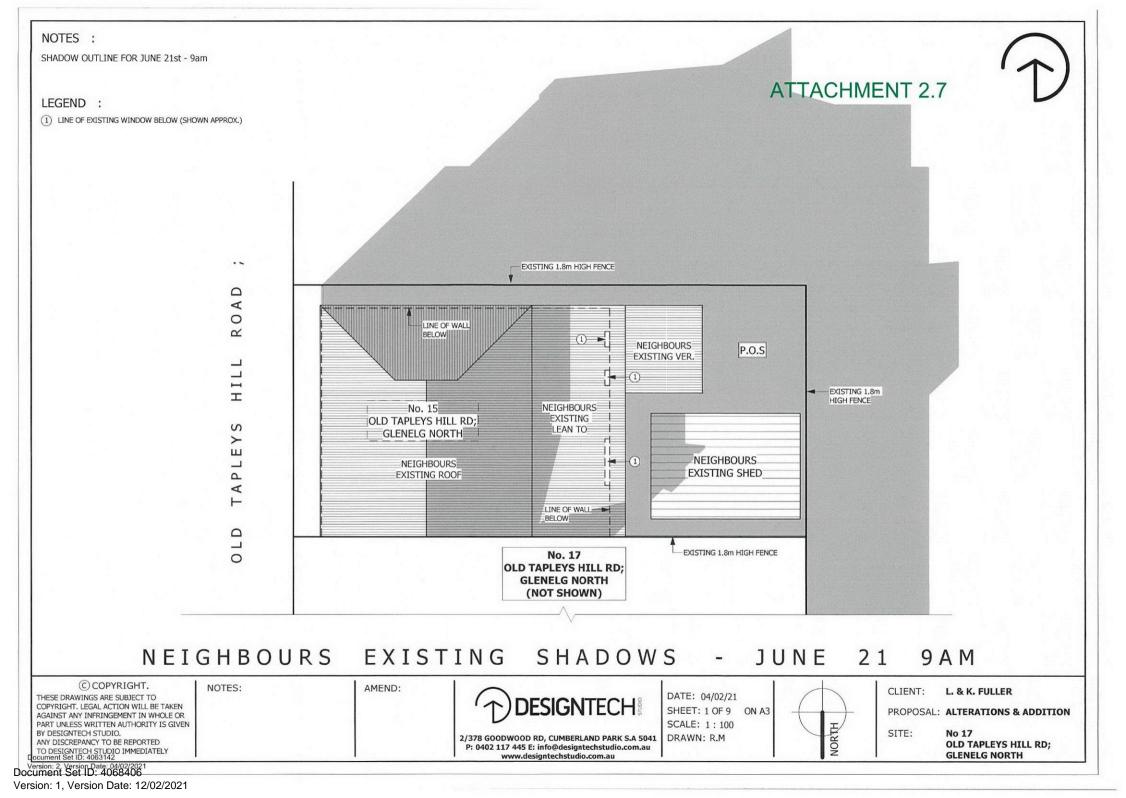




SHADOW OUTLINE FOR JUNE 21st - 12pm

#### LEGEND :


(1) LINE OF EXISTING WINDOW BELOW (SHOWN APPROX.)

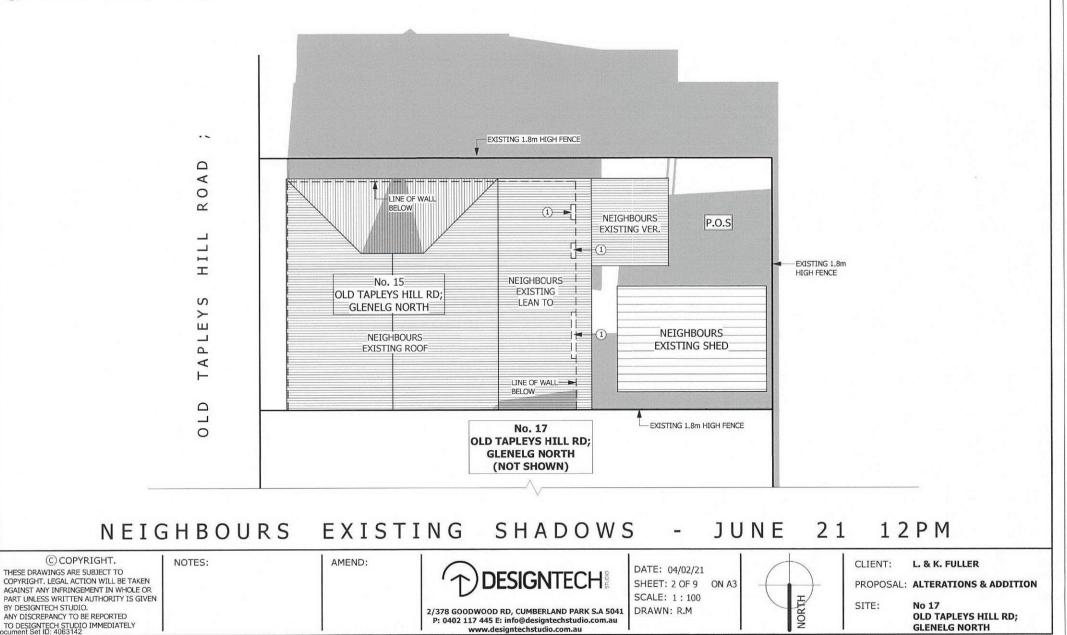

ATTACHMENT 2.8

BY DESIGNTECH STUDIO.

Document Set 1D. 40684061

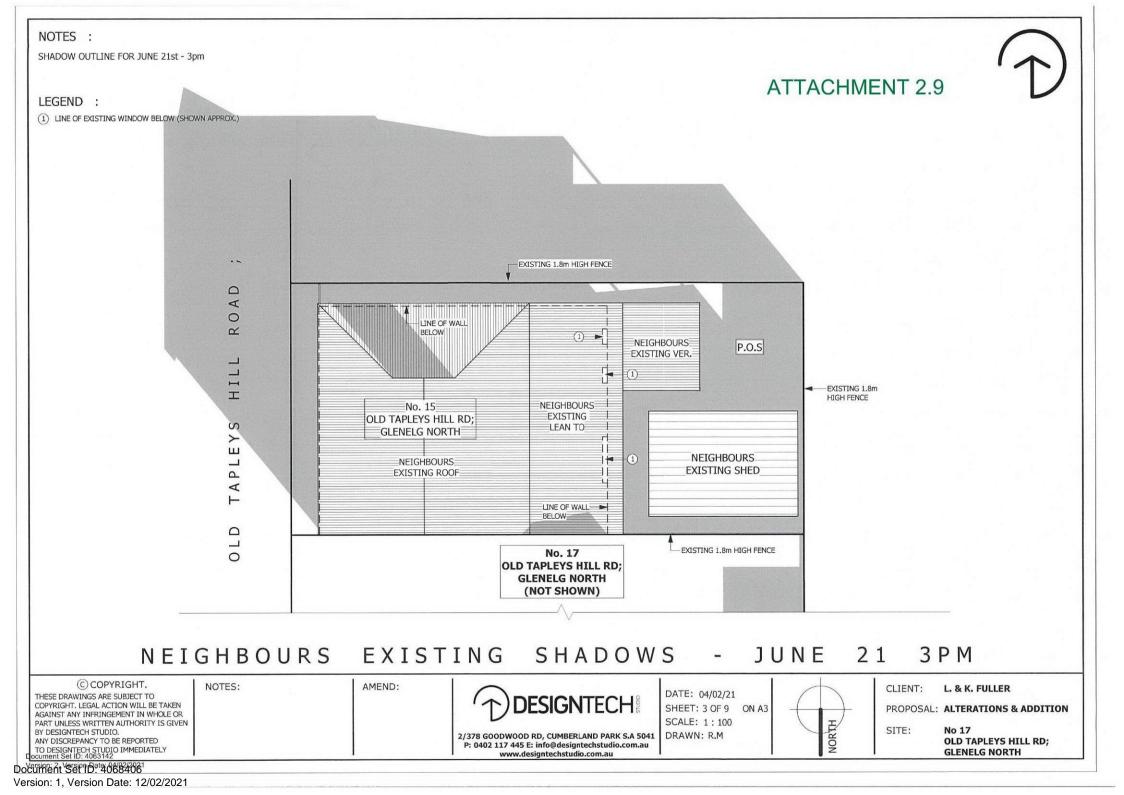


SHADOW OUTLINE FOR JUNE 21st - 9am

#### LEGEND :

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MELBOURNE STREET ;


# EXISTING SHADOW DIAGRAM - JUNE 21 9AM

	© COPYRIGHT. THESE DRAWINGS ARE SUBJECT TO COPYRIGHT. LEGAL ACTION WILL BE TAKEN AGAINST ANY INFRINGEMENT IN WHOLE OR	NOTES:	AMEND:	DESIGNTECH	DATE: 04/02/21 SHEET: 4 OF 9 ON A3		CLIENT: PROPOSAL	L. & K. FULLER .: ALTERATIONS & ADDITION
	PART UNLESS WRITTEN AUTHORITY IS GIVEN BY DESIGNTECH STUDIO. ANY DISCREPANCY TO BE REPORTED TO DESIGNTECH STUDIO IMMEDIATELY ocument 84 ID: 4063142	-		2/378 GOODWOOD RD, CUMBERLAND PARK S.A 5041 P: 0402 117 445 E: info@designtechstudio.com.au www.designtechstudio.com.au	SCALE: 1:200 DRAWN: R.M	NORTH	SITE:	No 17 OLD TAPLEYS HILL RD; GLENELG NORTH
Do	cument Set ID: 4068406							
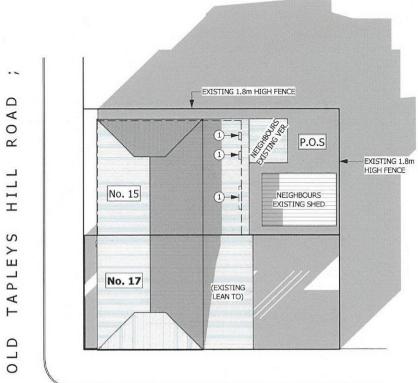
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ATTACHMENT 2.11

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SCALE: 1:200

DRAWN: R.M

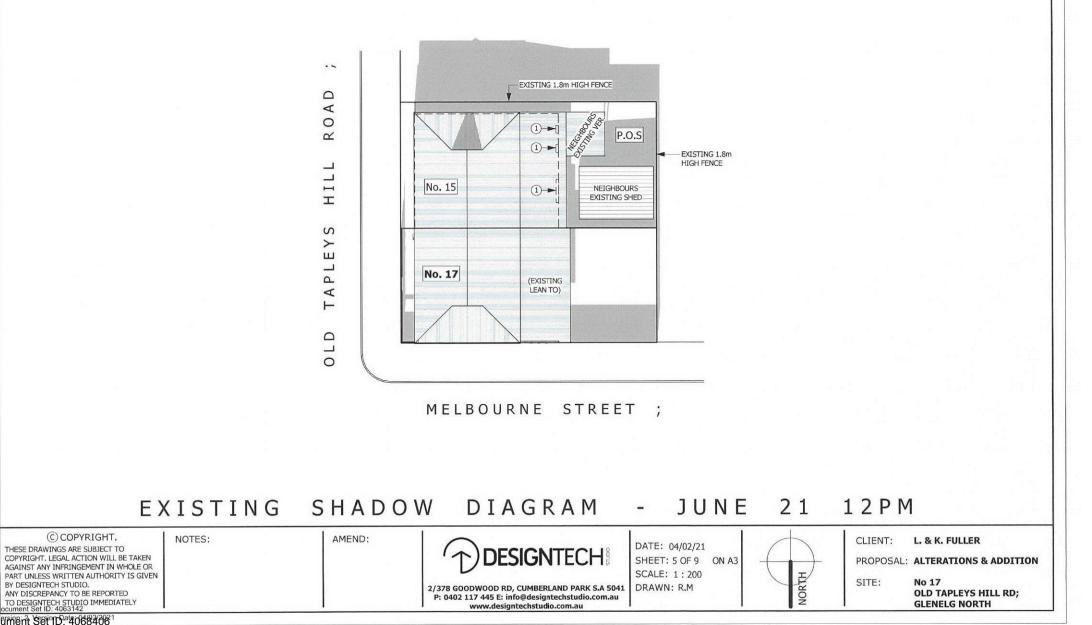NORTH


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No 17


OLD TAPLEYS HILL RD;

**GLENELG NORTH** 

ATTACHMENT 2.12

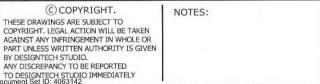


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SHADOW OUTLINE FOR JUNE 21st - 12pm
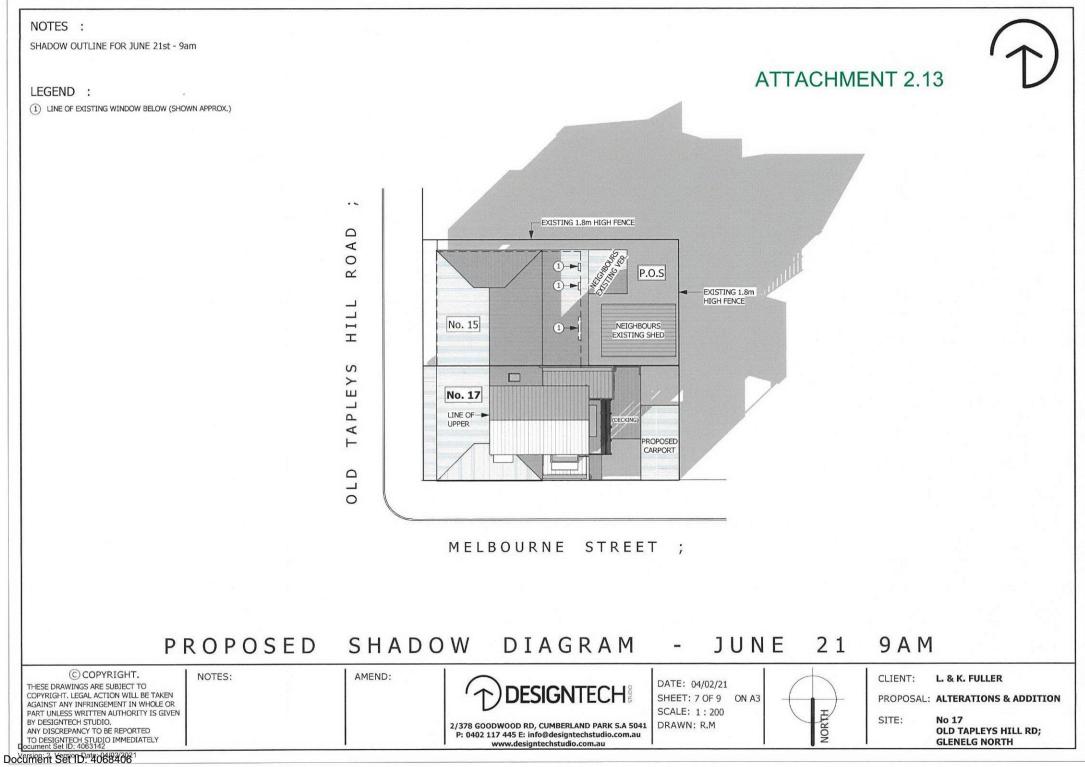
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AMEND:

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DATE: 04/02/21

SCALE: 1:200

DRAWN: R.M

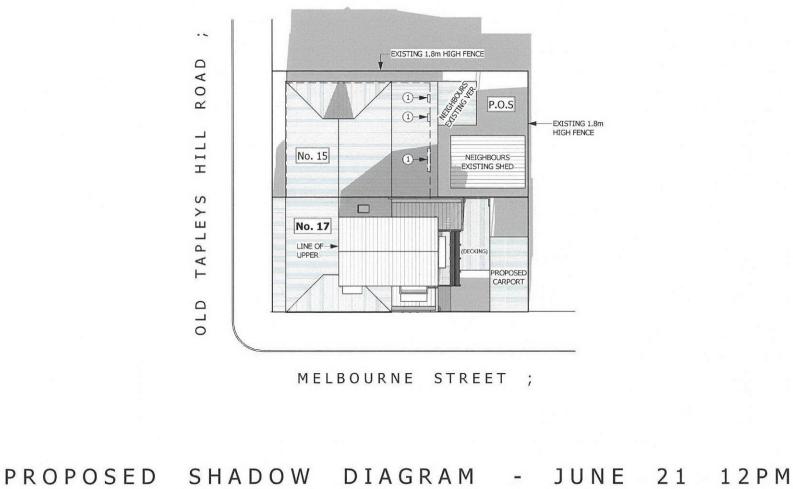SHEET: 8 OF 9 ON A3

NORTH

ATTACHMENT 2 14

CLIENT: L. & K. FULLER **PROPOSAL: ALTERATIONS & ADDITION** 

SITE: No 17

**OLD TAPLEYS HILL RD; GLENELG NORTH** 



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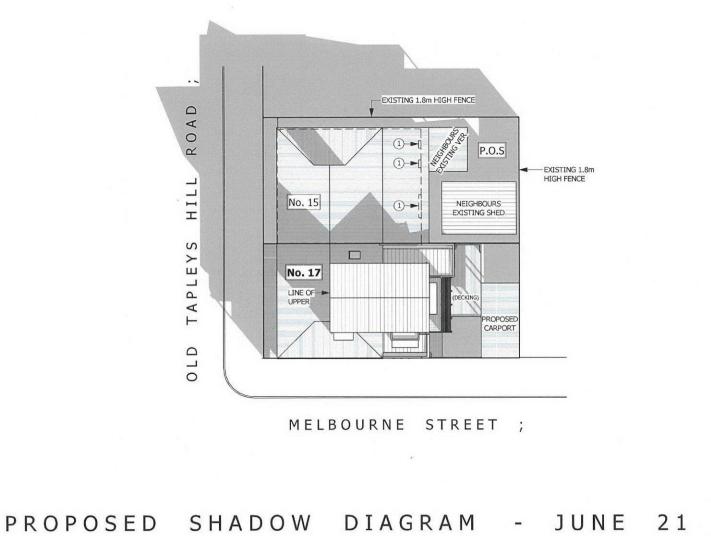
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**DESIGNTECH** 

2/378 GOODWOOD RD, CUMBERLAND PARK S.A 5041

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www.designtechstudio.com.au

21 3PM

SITE:

NORTH

DATE: 04/02/21

SCALE: 1:200

DRAWN: R.M

SHEET: 9 OF 9 ON A3

**ATTACHMENT 2 15** 

CLIENT: L. & K. FULLER

PROPOSAL: ALTERATIONS & ADDITION

No 17 OLD TAPLEYS HILL RD; GLENELG NORTH



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NOTES:

AMEND:

## ATTACHMENT 3.0 STATEMENT OF REPRESENTATION

Pursuant to Section 38 of the Development Act, 1993

To:	City of Holdfast Bay
	Development Services

(Please mark to the attention of the relevant contact officer)

#### PO Box 19 BRIGHTON SA 5048

Telephone: (08) 8229 9862; Facsimile: (08) 8298 4561 or Email: mail@holdfast.sa.gov.au

Development Number Please quote 110/00940/20

Name of person(s) making representation: \_Elizabeth Kiely\_

Address: 15 Old Tapleys Hill Road, Glenelg North, SA 5045\_

Contact no. 04035029336\_

#### Nature of interest affected by development:

(eg adjoining resident, owner of land in vicinity, on behalf of an organisation or company etc)

#### Adjoining resident,\_

#### **Reasons for representation:**

Concerns with the plans and the effect it will have on my residence

1. Proposed southern wall on the boundary appears to exceed height of max wall on boundary height for this policy area (as per DP) – please confirm?

2. Upper storey setbacks appear to be less than required for this policy area (as per DP) – Please confirm 1.57 to southern.

3. Confirmation of proposed specification of skylight to proposed bath/laundry to be confirmed given the proximity to boundary.

4. Material construction method to new wall on boundary doesn't appear to be provided and/or agreed by neighbour

5. Due to new wall on boundary to south over shadowing to neighbour, light will be significantly reduced given neighbour's aspect of rear yard. Have shadow diagrams been provided?

#### My representation would be overcome by:

(State action sought)

All the 5 points listed above have been satisfactorily resolved.

A copy of the representation above will be forwarded to the applicant for a written response before being presented at the next available development assessment panel meeting.

In the case of Category 2 and 3 developments please indicate in the appropriate box below whether or not you wish to be heard by the city of holdfast bay development assessment panel in respect to the above submission. **Please note that there are no speaking rights for Category 1 development**.

- I do not wish to be heard
- I desire to be heard personally

• I will be represented by

I do not wish to be heard (Please specify)

0

Please note that there are no rights of appeal for Category 1 and 2 developments (according to Development Act and Regulations, 1993).

EKiely

Signed

Date 30/12/2020



## **ATTACHMENT 4.0**



2/378 Goodwood Road, Cumberland Park SA 5041 ABN 54 289 363 825

04/02/2021

### **RESPONSE TO REPRESENTATION**

DA: 110/00940/20 17 Old Tapleys Hill Road, Glenelg North SA 5045

To whom it concerns,

We have tried to contact Ms Kiely of 15 Old Tapleys Hill Road in Glenelg North by phone, email & letter drop to directly address her concerns to no avail. In relation to the representation received from Ms Kiely:

1: The proposed Southern wall on boundary is to be constructed to match the height of existing boundary wall. It will be extended 2.5m longer than the existing wall on boundary.

2: Upper storey side setbacks are 2.0m & 1.57m respectively. As demonstrated in our 'Shadow Diagrams' provided the effects of the upper storey are negligible. In fact Ms Kiely's own shed & verandah already over shadow much of her own rear yard & property.

3: The proposed skylight is a Velux vented roof window which meets all Australian Standards & the BCA. We would not expect this to have any impact on any neighbours.

4: The proposed boundary wall is a HardieTex rendered wall system constructed from 7.5mm thick fibre cement sheeting that is texture coated & painted. (Surf mist in colour).

5: Shadow diagrams have been provided. The additional 2.5m on Southern boundary has little to no effect on overshadowing.

Please feel free to contact me if there are any additional questions or concerns.

Kind Regards, Travis Dunning B.Arch