REPORT NUMBER: 325/20

TO: COUNCIL ASSESSMENT PANEL

DATE: **28 OCTOBER 2020**

SUBJECT: COUNCIL ASSESSMENT REPORT

AUTHOR: A STAMATOPOULOS

DEVELOPMENT OFFICER - PLANNING

ATTACHMENTS: 1. LOCALITY MAP

2. PROPOSAL PLANS

HEARING OF REPRESENTORS: NOT APPLICABLE

HEARING OF APPLICANT: NOT APPLICABLE

DA NO. : 110/00528/20

APPLICANT : DOMAIN BUILDING GROUP

LOCATION : 8 HAMILTON STREET, GLENELG NORTH

DEVELOPMENT PLAN : CONSOLIDATED 2 JUNE 2016

ZONE AND POLICY AREA : RESIDENTIAL ZONE

NATURE OF DEVELOPMENT: MERIT

PROPOSAL : TWO, TWO STOREY SEMI-DETACHED DWELLINGS WITH ASSOCIATED

SWIMMING POOLS

REFERRALS : NIL

CATEGORY : ONE

REPRESENTATIONS : NOT APPLICABLE

RECOMMENDATION : DEVELOPMENT PLAN CONSENT SUBJECT TO CONDITIONS

1. Background

An application was lodged to the Council on 15 July 2020 to construct two, two storey semi-detached dwellings with associated swimming pools. An application for the site was also lodged to the Council on 21 July 2020 to create two allotments from one in the form of a Torrens Title Land Division. The division proposed two allotments each with 408sqm areas and allotment frontages of 9.38m for the western-most and 9.39m for the eastern-most allotment. It was noted that party walls were shown on the division suitable for the construction of semi-detached dwellings. The land division application was issued with approval under staff delegation. The street tree located at the front of the dwelling will be removed given the defect at the base.

2. Site and Locality

The subject site is located on 8 Hamilton Street Glenelg having a frontage facing south and is two allotments in from Patawalonga Frontage. The property and surrounding immediate locality are located in the Residential Zone. A predominance of single dwellings characterises the immediate locality to the west of the site in the form of residential flat buildings and detached dwellings. The built form along Hamilton Street is generally single storey in height with the exception of 7 Hamilton Street which is a recently constructed two storey dwelling. Low and medium density housing is found in the immediate locality.

Refer to Attachment 1

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3. Proposed Development

The applicant proposes to construct two conventional two-storey semi-detached dwellings each with their own swimming pools. The façade of the dwellings resemble a modern style of architecture characterised by vertical and horizontal components, a rendered finish and cantilevered upper levels. The second storey contains balconies which have the ability to obtain views of the Adelaide Hills and Patawalonga River. Each residence contains a lap pool located between the open living areas and internal boundaries of the allotments.

Refer to Attachment 2

4. Procedural Matters

The application is a Category 1 development subject to Part 1 2(2)(a)(iii)

- 2 Except where the development is classified as non-complying under the relevant Development Plan, any development which comprises—
 - (a) the construction of any of the following (or of any combination of any of the following):
 - (i) 1 or more detached dwellings;
 - (ii) 1 or more single storey dwellings;
 - (iii) 1 or more sets of semi-detached dwellings, provided that no such dwelling is more than 2 storeys high;

The application did not trigger any referrals subject to Schedule 8 of the Development Regulations.

5. Development Data

DEVELOPMENT DATA DWELLING A			
Aspect	Proposed	Development Plan	Compliance
Site Coverage	56%	50%	6% shortfall
Private Open Space	24%	20%	Complies
Primary Setback			
- Dwelling	5.7m & 6.8m	8.2m to 10.8m	Does not comply
- Garage	6.5m to 8.2m	adjoining setback of	
		western property	
Side Setbacks			
Western Side			
- Lower Level	.900mm to 1m	<u>1m</u>	Complies
- Upper Level	1.8m to 2.4m	<u>2.8m</u>	100mm to 700mm shortfall
Eastern Side			
- Lower Level	.900mm to 1m	<u>1m</u>	Complies
- Upper Level	1.8m to 2.4m	<u>2.5m</u>	100mm to 700mm shortfall
Rear Setback			
- Lower Level	8.8m	<u>4m</u>	Complies
- Upper Level	13.2m	<u>6m</u>	Complies

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DEVELOPMENT DATA DWELLING A			NG A
Aspect	Proposed	Development Plan	Compliance
Total Wall Height	6.3m	<u>7m</u>	Complies
	DEVEL	OPMENT DATA DWELLI	NG B
Aspect	Proposed		Compliance
Site Coverage	56%	50%	6% shortfall
Private Open Space	24%	20%	Complies
Primary Setback			
DwellingGarage	7.7m & 8.2m 8.1m to 9.1m	8.2m to 10.8m adjoining setback of western property	Does not comply
Side Setbacks			
Western Side			
- Lower Level	.900mm to 1m	<u>1m</u>	Complies
- Upper Level	1.8m to 2.4m	<u>2.8m</u>	100mm to 700mm shortfall
Eastern Side		4	Complian
- Lower Level	.900mm to 1m	1 <u>m</u>	Complies 100mm to 700mm shortfall
- Upper Level Rear Setback	1.8111 (0 2.4111	<u>2.5m</u>	10011111 to 70011111 SHOTETAL
- Lower Level	6.6m	4m	Complies
- Upper Level	11.7m	6m	Complies
Total Wall Height	6.3m	7m	Complies
Total wan ficigit	0.5111	7	Compiles

6. Development Plan Provisions

HOLDFAST BAY (CITY) DEVELOPMENT – ASSESSMENT – RESIDENTIAL ZONE AND POLICY AREAS – OBJECTIVES AND PRINCIPLES OF DEVELOPMENT CONTROL

RESIDENTIAL ZONE				
Objectives				
1. A residential zone comprising a range of dwelling types,	Complies			
including a minimum of 15% affordable housing.				
3. Development that contributes to the desired character of	Complies			
the zone.				
Desired Character				
Development outside of the policy areas will be suburban in	Complies			
nature and evolve in response to progressive infill				
development of existing individual sites and through				
consolidation of sites to form larger comprehensive				
redevelopment opportunities. Infill development outside of				
the Policy Areas will not compromise the suburban character				
but will progressively increase dwelling densities through				
unobtrusive small-scale developments. In this regard, infill				
development will have a comparable height, mass, scale and				
setbacks to that of existing dwellings in the relevant locality.				
The zone's primarily suburban character outside of the				
policy areas is defined by detached dwellings on individual				
allotments. Infill development in these suburban areas will				
contribute to the city's housing diversity through				
development opportunities that (in order of preference):				

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Desired Character (Cont)			
(a) increase dwelling numbers on allotments that have dual room	ad frontages		
Development outside of the policy areas will comprise:			
Single storey in areas east of Brighton Road, and up to two storeys in areas west of Brighton Road.	Complies		
 Buildings both domestic and contemporary in design and character to support and reinforce the essentially suburban character through typical domestic design forms, low front fencing and landscaping. 	Complies		
 Materials and finishes that respond to the character of the immediate locality and utilise brick, stone and rendered finishes to provide visual interest to facades. 	Complies		
 Architectural design and detailing that responds to localised character by way of fenestration, doorways, windows, eaves and roof forms. 	Complies		
 Development will be setback and be orientated to minimise impacts of the privacy of neighbouring residents. 	Complies		
 The following forms of development are envisaged in the zone: affordable housing domestic outbuilding in association with a dwelling domestic structure dwelling dwelling addition small scale non-residential use that serves the local community, for example: child care facility health and welfare service open space primary and secondary school recreation area supported accommodation. 	Complies		
Principles of Development Control			
6. Development should not be undertaken unless it is consistent with the desired character for the zone.	Complies		
8. Dwellings and residential flat buildings, except where specifi maximum heights shown in the following table:	ed in a particular policy area or precinct, should not exceed the		

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Principles of Development Control (Cont)			
Location of the dwelling	Maximum wall height above natural ground level	Maximum height above natural ground level	Complies
West of Brighton Road or Tapleys Hill Road East of Brighton Road or Tapleys Hill Road	7 metres	Two storeys	
	3.5 metres	One storey, or two storeys if the second storey is incorporated within the roof space and the floor area of the second storey does not exceed 40 percent of the ground floor footprint of the dwelling, including attached garages.	
9. Dwellings and/or residential flat buildings should be	Complies		
setback a minimum of 1 metre from one side boundary to			
incorporate pedestrian access.			,

HOLDFAST BAY (CITY) DEVELOPMENT PLAN – ASSESSMENT – RESIDENTIAL - COUNCIL WIDE – PRINCIPLES OF DEVELOPMENT CONTROL

Residential Development	
5. Residential development should be designed to ensure living rooms	Complies
have an external outlook.	
10. The design and location of buildings should ensure that direct	Complies
winter sunlight is available to adjacent dwellings, with particular	
consideration given to:	
(a) windows of habitable rooms (all rooms excluding bathrooms,	
laundries and hallways), particularly living areas	
(b) ground-level private open space	
(c) upper-level private balconies that provide the primary open space	
area for any dwelling	
(d) access to solar energy.	
11. Development should ensure that north-facing windows to habitable	Complies
rooms (all rooms excluding bathrooms, laundries and hallways) of	
existing dwelling(s) on the same allotment, and on adjacent allotments,	
receive at least 3 hours of direct sunlight over a portion of their surface	
between 9 am and 5 pm on the 21 June.	
12. Development should ensure that ground-level open space of	Complies
existing buildings receives direct sunlight for a minimum of two hours	
between 9 am and 3 pm on 21 June to at least the smaller of the	
following:	
(a) half of the existing ground-level open space	
(b) 35 square metres of the existing ground-level open space (with at	
least one of the area's dimensions measuring 2.5 metres)	
Development should not increase the overshadowed area by more than	
20 per cent in cases where overshadowing already exceeds these	
requirements.	

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Residential Development (Cont)		
14. Garages and carports facing the	street should not dominate the	(a)
streetscape and should be designed		(-)
(a) have a maximum total width of g	=	
metres or 50 per cent of the dwellin		
1	g frontage width, whichever is the	
lesser	hindaha wain faarafaha araasinaad	
1 * *	hind the main face of the associated	
dwelling		
(c) where it is in the form of an enclo		
setback at least 8 metres from the p	rimary road frontage and	
incorporate one of the following:		
(i) two individual doors with a distar	nce of not less than 300 millimetres	
between them		
(ii) double tilt-up doors with moulde	ed door panels having a maximum	
width of no more than 5 metres		
(d) be constructed of materials that	integrate with those of the	
associated dwelling, or pre-coloured		
19. Except where specified in a part		
policy area or precinct or Residentia		
Density Zone , the main face of a bu		
be set back from the primary road f		Does not comply
accordance with the following table		
difference between buildings on ac		
allotments with frontage to the sar	ne primary	
street	The	
Up to 2 metres	The same	
	setback as one of	
	the adjacent	
	buildings, as	
	illustrated below:	
Greater than 2 metres	At least the	
	average setback	
	of the adjacent	
	buildings.	
20. Dwelling setbacks from side and	rear boundaries should be	Reasonably complies – the side upper level walls of the
progressively increased as the heigh	t of the building increases to:	dwellings are stepped to alleviate visual bulk however do
(a) minimise the visual impact of bui	ildings from adjoining properties	not satisfy the quantitative setback requirements.
(b) minimise the overshadowing of a		
21. Residential development (other		
	ir boundaries in accordance with the	·
following parameters:		
Parameter	Value	
		Complies
Side walls with a height up to (and	1 metre	Complies
including) 3 metres at any point		
above the natural ground level		
Side walls with a height exceeding	1.5 metres plus an additional	Complies
_		Compiles
3 metres and up to (and including) 500mm for every metre in height		·
6 metres at any point above the	above 4 metres	
natural ground		2
Side walls greater than 6 metres 2.5 metres plus the increase in		Does not comply
at any point above the natural wall height above 6 metres		
ground level		
Rear boundary setback for single	4 metres	Complies
storey buildings with a wall height		
3 metres or less above natural		
ground level		
<u> </u>	1	

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Residential Development (Cont)		
Rear boundary setback for a	6 metres	Complies
building of two or more storeys		
with a wall height more than 3		
metres above natural ground level		
28. Site coverage (the proportion of a	a site covered by ground floor level	
buildings and structures including dw		
and outbuildings but excluding unroc		
balconies) should not exceed the following		Both dwellings exceeds anticipated maximum by 6%
Parameter	Value	
Site with an area less than or equal	60 per cent	
to 300 square metres		
Site with an area greater than 300	50 per cent	
square metres		
29. Site coverage should be limited to	ensure sufficient space is	
provided for:	•	Complies
(a) vehicle parking		Compiles
(b) domestic storage		
(c) outdoor clothes drying		
(d) a rainwater tank		
(e) private open space and landscaping	ng	
(f) front, side and rear boundary setb		
character of the area		
(g) convenient storage of household	d waste and recycling receptacles	
31. Private open space (land available	e for exclusive use by residents of	Complies
each dwelling) should be provided fo		·
dwelling within a residential flat build		
designed:	<u> </u>	
(a) to be accessed directly from the in	nternal living areas of the dwelling	
(b) generally at ground level to the si		
screened for privacy	-	
(c) to take advantage of but not adve	rsely affect natural features of the	
site		
(d) to minimise overlooking from adja		
(e) to achieve separation from bedro	om windows on adjoining sites	
(f) to have a northerly aspect to prov	ide for comfortable year-round use	
(g) to not be significantly shaded duri	ing winter by the associated	
dwelling or adjacent development		
(h) to be shaded in summer.		
32. Dwellings and residential flat buil		Complies
include private open space that confo	orms to the requirements	
identified in the following table:		
Site area of dwelling - 250 square me		
Minimum area of private open space	e - 20 per cent of site area.	
Provisions		
Balconies, roof patios, decks and the		
provided the area of each is 10 squar		
One part of the space should be direct	•	
lounge room, dining room or living ro		
have an area equal to or greater than		
minimum dimension of 5 metres and		Constitution
33. Private open space should not inc		Complies
(except where it is a group dwelling t		
road and the private open space is so		
effluent drainage areas, rubbish bin s		
and other utility areas and common a	areas such as parking areas and	
communal open space.		· ·

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Residential Development (Cont)	
40. Except for buildings of 3 or more storeys in the Minda Incorporated	Does not comply
Brighton Campus, upper level windows, balconies, terraces and decks	
that overlook habitable room windows or private open space of	
dwellings should maximise visual privacy through the use of measures	
such as sill heights of not less than 1.7 metres or permanent screens	
having a height of 1.7 metres above finished floor level.	
41. Where development is greater than single storey (excluding the	
Minda Incorporated Brighton Campus):	Complies
(a) any upper storey window that directly overlooks the private open	
space of an adjoining residential property that is within 30 metres	
from the vertical centre line of the overlooking window and beyond	
a 45 degree angle from the plane of the wall containing the	
overlooking window (as illustrated by the figure below) should be	
glazed in fixed obscure glass or have window sills a minimum of 1.7	
metres above the upper floor level:	Complies
(b) (b) any upper storey window that directly overlooks habitable	
rooms (all rooms excluding bathrooms, laundries and hallways) of	
residential buildings that are within 15 metres from the vertical	
centre line of the overlooking window and beyond a 45 degree	
angle from the plane of the wall containing the overlooking window	
(as illustrated by the figure below) should be glazed in fixed	
obscure glass or have window sills a minimum of 1.7 metres above	
the upper floor level:	Complies
(c) (c) any upper storey balcony should be located and/or designed to	'
avoid directly overlooking the private open space of adjoining	
residential properties and into habitable rooms (all rooms excluding	
bathrooms, laundries and hallways) of other dwellings.	

7. Summary of Assessment

The application complies with a majority of the quantitative objectives and principles of the Holdfast Bay Development plan. The following assessment will touch on aspects of the application which requires further discussion.

Setbacks

A shortfall in the primary setbacks of the proposed dwellings were noted during the quantitative assessment of the application. PDC 19 of the General Section Residential Development anticipates dwellings to contain the same setback as the adjacent buildings with a frontage to the same primary street. The property to the east is located on the corner of Hamilton Street and Patawalonga Frontage where its primary frontage is toward Patawalonga Frontage and not Hamilton Street. As this is the case, to satisfy PDC 19, the primary setback of 6 Hamilton Street which adjoins the subject site to the west is there reference point to determine the primary setbacks.

6 Hamilton Street contains a varied primary setback of 8.2m to 10.8m due to the angled nature of the front boundary. The proposal contains setbacks varying from 5.7m to 8.2m for dwelling A and 7.7m to 9.1 for dwelling B, therefore not complying with PDC 19.

The aerial below shows the dwelling superimposed over the subject along with the setback pattern of the northern side of Hamilton Street.

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The streetscape of Hamilton Street contains inconsistent dwelling styles and varied setbacks both on the northern and southern side. There are two examples of carports located forward of dwellings at 1 and 2 Hamilton Street where both are in close proximity to the primary boundaries of their respective allotments.



Above: 2 Hamilton Street Glenelg North **Below:** 1 Hamilton Street Glenelg North

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Further it is also noted that the recently approved two storey dwelling located directly opposite the site at 7 Hamilton Street has been approved with a primary setback of 3.9m to the dwelling wall and 6.2m to the garage.



While it is noted that from a quantitative perspective the primary setbacks of the dwelling do not comply with the development plan, there is merit for the proposed setbacks when assessed in context with the immediate locality.

While the units to the east of the site are not considered during the quantitative assessment their location is vital when assessing how the dwellings will sit on the site and their impacts to the locality. The dwellings will be located well behind the units and the associated garage.

The Desired Character of the Residential Zone anticipates progressive infill development where sites like the proposed are considered suitable for land division. While it would be ideal that the primary setbacks of the dwellings replicate those to the west, the fact that the land has been divided in half must be taken into consideration. The allotments therefore have approximately half the space to accommodate a dwelling than the neighbouring dwelling to the west which remains intact as an original allotment.

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As sites like the proposed become divided it is fair to anticipate that primary setbacks of dwellings will be lesser than those of existing original allotments where a much larger area is available to accommodate built form. Notwithstanding, the proposed setbacks are considered to be substantial for the site particularly where a two storey dwelling across from the site has been approved with setbacks of 3.9m and 6.2m albeit on an allotment with lesser depth.

The upper level side setbacks of the dwelling do not comply with PDC 21 of the General Section – Residential Development. The side walls of the dwellings contain a height of 6.3m from natural ground level which anticipates an upper level side setback of 2.8m. The internal upper level setbacks of 1.1m are well short of 2.8m however given their siting impacts are considered to be minor.

The external upper level side wall setbacks are 2.4m to the front of the dwelling which then step out to 1.8m toward the rear. Impacts of overshadowing are considered to be negligible given the siting of the dwelling. All adjoining neighbouring private open space areas and northern habitable windows will be subject to adequate sunlight during the winter solstice satisfying PDC's 11 and 12 of the General Section – Residential Development.

Visual Privacy

Concerns were raised regarding the front balconies and their potential to overlook the private open space of 33 Patawalonga Frontage. The aerial below shows the subject site and its proximity to 33 Patawalonga Frontage.



The visual privacy inconsistencies we

re referred to where

PDC 40 states:

Except for buildings of 3 or more storeys in the Minda Incorporated Brighton Campus, <u>upper level</u> windows, <u>balconies</u>, terraces and decks <u>that overlook habitable room windows or private open space</u> of dwellings should maximise visual privacy through the use of measures such as sill heights of not less than 1.7 metres or permanent screens having a height of 1.7 metres above finished floor level.

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PDC 41(c) states:

Where development is greater than single storey (excluding the Minda Incorporated Brighton Campus):

(c) any upper storey balcony should be located and/or designed to avoid directly overlooking the private open space of adjoining residential properties and into habitable rooms (all rooms excluding bathrooms, laundries and hallways) of other dwellings.

PDC 41 makes it clear that screening should be implemented on balconies that are *adjoining* the site of the development. However, PDC 40 states that balconies that overlook private open of dwellings should implement screening devices with no mention as to whether this applies to directly adjoining properties. In the circumstances of the application it is considered that there is potential for a loss of visual privacy to the private open space of 33 Patawalonga frontage.

Concerns of overlooking were raised with the applicant who provided a line of sight diagram showing views from the front balconies. The diagram shows that views into the private open space of 33 Patawalonga Frontage will be slightly screened by the boundary fence however views into the alfresco area and back yard will remain in view.

Due to the contradiction of Council policy regarding visual privacy, the requirement for screening needs to be balanced with the potential outlook from the balconies. There is scope for regard to be given to the policies of the Residential Code regarding front facing balconies and their relationship to dwellings on adjacent land. It must be noted that the subject site is not located in a gazetted area for Residential Code assessment however to provide context for the situation a discussion could prove to be beneficial.

Schedule 4 Part 2B of the Development Regulations states that:

the dwelling will not have a balcony or terrace on an upper storey, other than where the longest side of that balcony or terrace will face a road (including any road reserve), or reserve (including any land held as open space), that is at least 15 metres wide at all places to be faced by the dwelling.

This policy states that if the road reserve has width greater than 15m a balcony without any screening devices is permissible to be built. The width of the road reserve of Hamilton Street is 15.3m and therefore a balcony would be compliant.

A potential solution is to place a condition on the assessment which can then be reviewed during construction in order to assess impacts of overlooking if the Council Assessment Panel determines that screening devices should be implemented to the front balconies.

Conclusion

When assessed against the relevant provisions of the Development Plan and having regard to the context of the locality and the nature of the proposed development, it is considered that the proposal as amended on balance satisfies the relevant provisions of the Development Plan. The proposal is broadly consistent with the desired character of the zone and will not detrimentally impact upon the amenity of the adjoining properties of the locality. Accordingly, the proposal warrants Development Plan Consent subject to conditions.

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8. RECOMMENDATION

1. The proposed development is NOT seriously at variance with the policies in the Development Plan.

2. Following a detailed assessment of the proposal against the provisions of the Holdfast Bay (City) Development Plan, the Council Assessment Panel resolves to grant Development Plan Consent to Development Application 110/00528/20 subject to the following conditions:

PLANNING CONDITIONS

- 1. That the design and siting of all buildings and structures and site works shall be as shown on the plans submitted to and approved by Council unless varied by any subsequent conditions imposed herein.
- 2. That storm water from the dwellings shall be collected and connected to a 1000 litre (minimum) rainwater tank with a sealed system over flow connection to the street water table. Final details of the location and size of the tank(s) shall be submitted to Council for approval prior to the issue of full Development Approval. Furthermore, all storm water from the dwelling and the site shall be collected and disposed of in a manner that does not adversely affect any properties adjoining the site or the stability of any building on adjacent sites.

NOTE:

Storm water shall not be disposed of over a vehicle crossing place and any connection to the street water table, including remedial works to footpaths, verges or other Council infrastructure, is subject to any necessary approvals from Council and will be at the applicant's cost.

- 3. The stormwater disposal system shall cater for a 5 year rainfall event with discharge to the street not to exceed 10 litres per second. Any excess above this flow is to be detained on site to the reasonable satisfaction of Council.
- 4. That all upstairs windows on the northern, western and eastern elevations shall have minimum window sill heights of 1.7 metres above finished floor level, or any glass below 1.7metres shall be manufactured obscure glass and fixed shut or as otherwise approved by Council. Further details of this requirement shall be provided at Building Rules Assessment stage.
- 5. That the filter pump associated with the swimming pool be enclosed in such a way that noise levels do not exceed 45db(a) between the hours of 10pm and 7am and 52db(a) between 7am and 10pm measured at adjoining property boundaries.









domain building group

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Document Set ID: 376355 Version: 1, Version Date: 20/10/2020

No.	Description	Date
Α	FL1 front setback incr.	29/07/20
Α	garage side wall relocated	29/07/20
Α	FL2 side setback increased	29/07/20
В	facade/layout mod.	2/09/20

Two Semi-Detached Two-Storey Dwellings at 8 Hamilton St., Glenelg North for A Shtjefni

2/09/20

DBG200420-P0B

Drawn by

3D Views



NOTE:

- Land division to create one additional alotment (1:2) pending application to SCAP (by Michael Grear Surveys)

SITE COVERAGE:

DWELLING A:

total site area

408.49 squ. metres

proposed dwelling FL1 proposed FL1 alfresco proposed dwelling FL2 proposed FL2 balcony 183.4 squ. metres 19.43 squ. metres 134.9 squ. metres 22.1 squ. metres

private open area

24.5% (100.0 squ. metres)

proposed plot ratio

49.7% (202.8/408.49)

DWELLING A:

total site area

408.49 squ. metres


proposed dwelling FL1 proposed FL1 alfresco proposed dwelling FL21 proposed FL2 balcony 183.4 squ. metres 19.43 squ. metres 134.9 squ. metres 22.1 squ. metres

private open area

20.8% (85.0 squ. metres)

proposed plot ratio

49.7% (202.8/408.49)

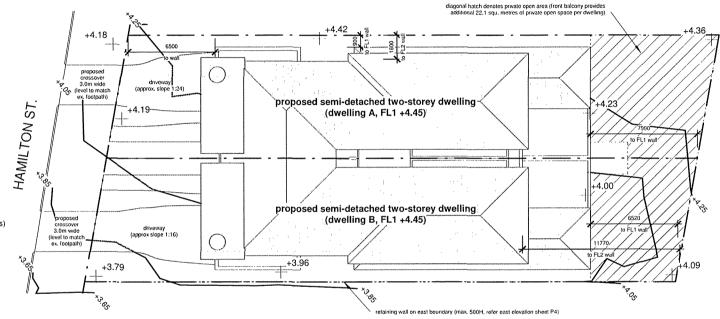





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Document Set ID: 376355

No.	Description	Date
Α	FL1 front setback incr.	29/07/20
Α	garage side wall relocated	29/07/20
Α	FL2 side setback increased	29/07/20
В	crossovers mod.	24/08/20
В	street tree removed	24/08/20
С	facade/layout mod.	2/09/20

Two Semi-Detached Two-Storey Dwellings at 8 Hamilton St., Glenelg North for A Shtjefni


2/09/20

DBG2004	120-P1C
Scale at A3	1:200
Drawn by	LDB

Site Plan

For Planning Approval

Version: 1, Version Date: 20/10/2020

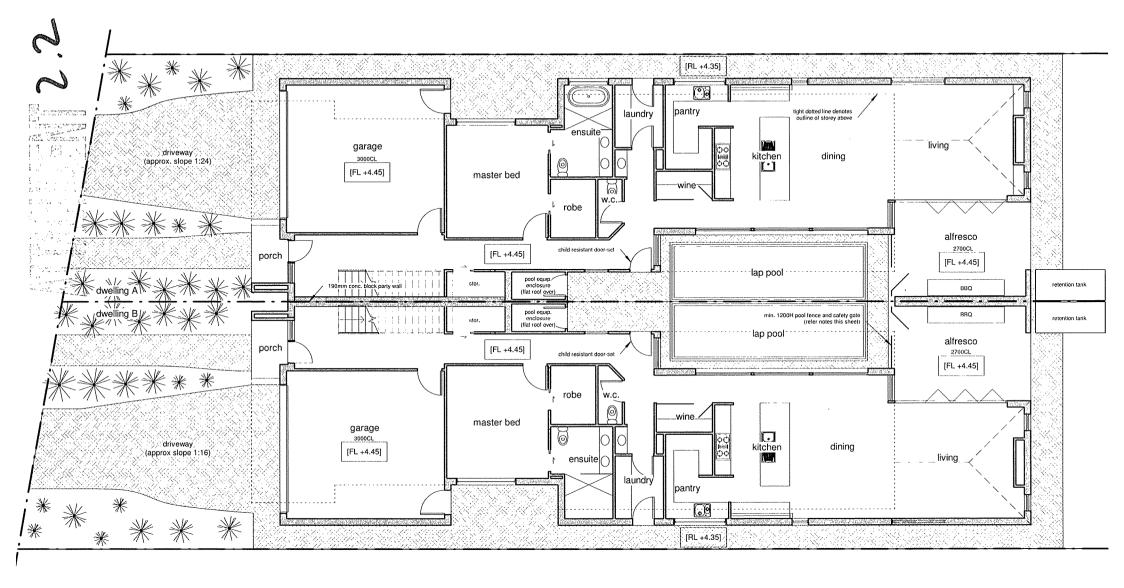

POOL FENCING:

to comply with AS1926 parts 1 & 2

- pool-fencing system to min. 1200H (w/ 900mm non-climbable zone) to comply with AS1926.1,
- height of fence above paving/ground level to be no more than 100mm
- pool-fence gates to be self-closing and outward swinging (fitted with self-latching and tamper-resistant devices, latch to be min. 1500 above GL)





domain building group

DO Boy 205 RELAID S A 5052

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D: 376355			


No.	Description	Date
Α	FL1 front setback incr.	29/07/20
Α	garage side wall relocated	29/07/20
В	crossovers mod.	24/08/20
С	facade/layout mod.	2/09/20
		i

Two Semi-Detached Two-Storey Dwellings at 8 Hamilton St., Glenelg North for A Shtjefni

2/09/20

Ground	Floor	Plan

DBG2004	20-P2C
Scale at A3	1:100
Drawn by	LDB

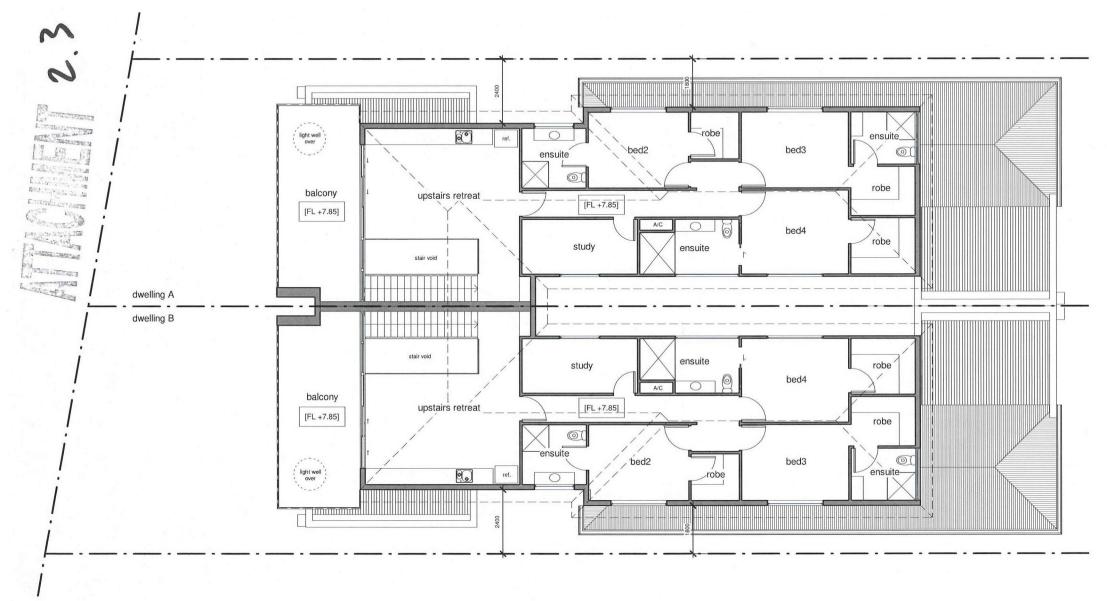





domai

(-)			
domain building group	Α	FL2 side setback increased	29/07/20
aomam sanang group	Α	ensuite window added	29/07/20
PO Box 295, BELAIR S.A. 5052	В	facade/layout mod.	2/09/20
10 Box 293, BELAIR S.A. 3032			
© 2020 office & fax (08) 8370 3766 mobile 0412 821 285			
Document Set ID: 376355			
Version: 1, Version Date: 20/10/2020			

No.

Description

Date

Two Semi-Detached Two-Storey Dwellings at 8 Hamilton St., Glenelg North for A Shtjefni


2/09/20

First Floor Plan

DBG200420-P3B Scale at A3

Drawn by

scale 1:100

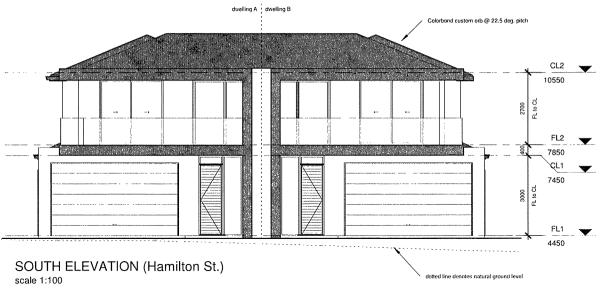

SCHEDULE OF COLOURS/MATERIALS:

ext. walls

door/window frames fascias/barges


autters downpipes garage door feature form

rendered (colour: light grey) hlack

painted Woodland Grev Woodland Grev to match walls

light grey

render finish (painted: Monument)

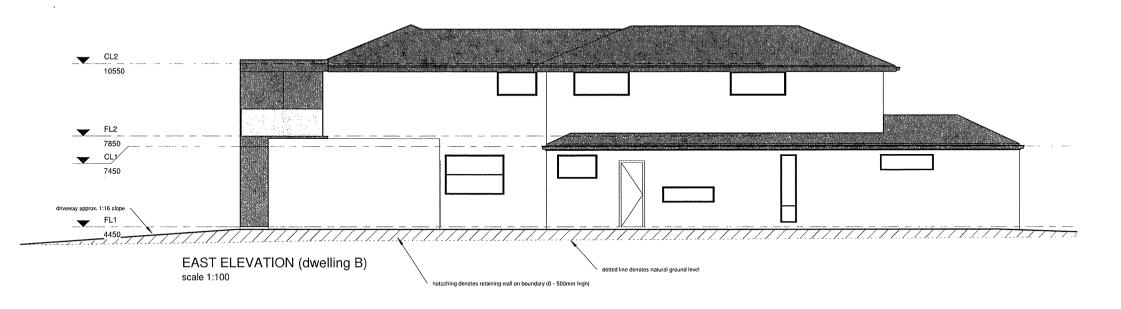



Version: 1, Version Date: 20/10/2020

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140.	Describition	Date
A	dwelling footprint changed	29/07/20
В	facade/layout mod.	2/09/20

Description

Data


Two Semi-Detached Two-Storey Dwellings at 8 Hamilton St., Glenelg North for A Shtjefni

2/09/20

South & East Elevations

DBG200420-P4B

Scale at A3 Drawn by

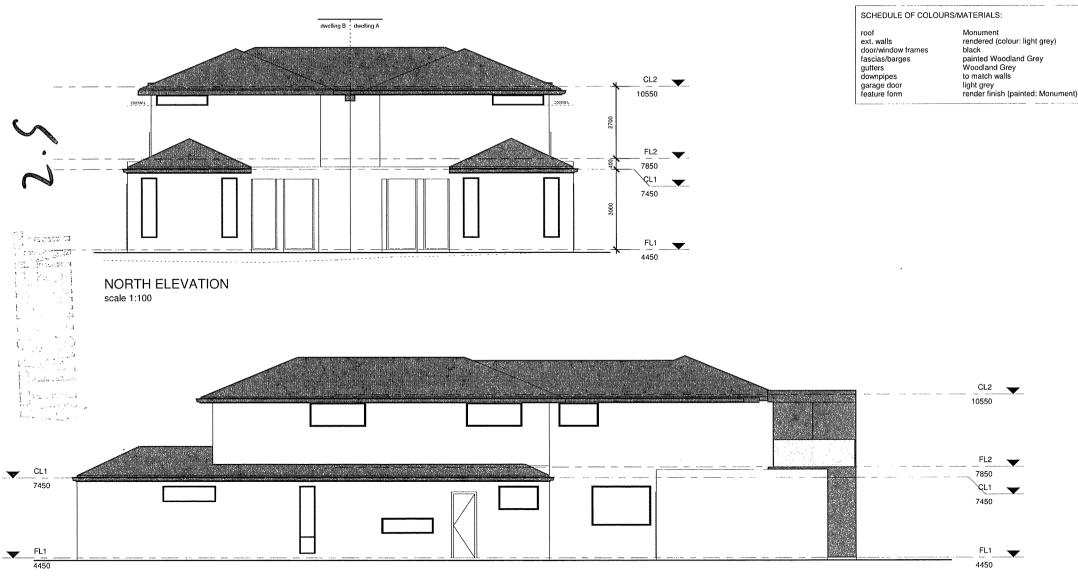

WEST ELEVATION (dwelling A) scale 1:100



domain building group

				crisuite milaon adaca
	PO Box 295, BELAIR S.A. 5052		В	facade/layout mod.
	1 O DOX 293, DELAIR S.A. 3032			
5 € 2020	office & fax (08) 8370 3766 mobile 0412 821 285			
Document Se	t ID: 376355	-	*********	
Marajan, 1 M	ersion Date: 20/10/2020			
V ersion. 1, ve	ersion Date. 20/10/2020			

Description

A dwelling footprint changed

Date

29/07/20 29/07/20

2/09/20


Two Semi-Detached Two-Storey Dwellings at 8 Hamilton St., Glenelg North for A Shtjefni

2/09/20

Drawn by

North & West Elevations DBG200420-P5B For Planning Approval



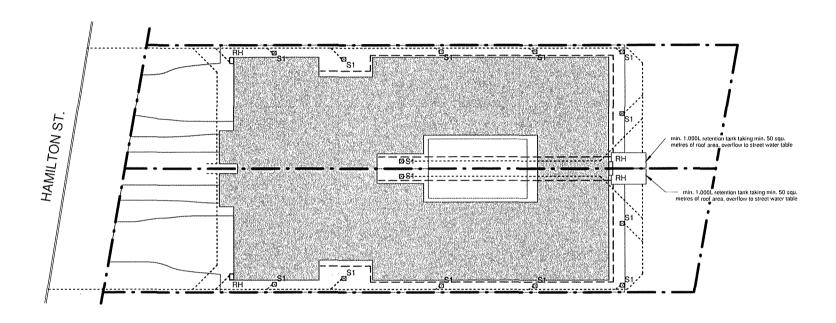

NOTE:

- all roofwater either to retention tank or street water table
- stormwater layout diagrammatic only

LEGEND:

S1 300x300 grated sump taking surface water (feeding to street water table)

rainhead connecting into u/ground s/water system feeding to retention tank

100mm sewer-grade PVC - d/pipes to retention tank

90mm PVC u/ground s/water - tank overflow & surface water to street water table (and rainhead/downpipes where shown)





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D: 376355		

*******	Description dwelling footprint changed crossovers mod. facade/layout mod.	Date 29/07/20 24/08/20 2/09/20	Two Se at

emi-Detached Two-Storey Dwellings 8 Hamilton St., Glenelg North for A Shtjefni

2/09/20


DBG2004	20-P6C
Scale at A3	1 : 200
Drawn by	LDB

Site Drainage Layout

For Planning Approval

Version: 1, Version Date: 20/10/2020



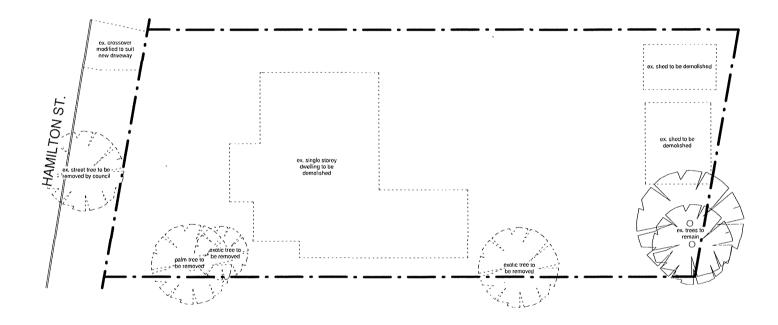

DEMOLITION NOTES:

- All demolished items are generally shown as dashed/hatched
- Any removal of asbestos to be carried out by an approved contractor
- All demolition work to comply with AS2601
- All services to be disconnected/sealed prior to demolition





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Two Semi-Detached Two-Storey Dwellings at 8 Hamilton St., Glenelg North for A Shtjefni

2/09/20

DBG200420-P7 <i>A</i>			
Scale at A3	1:200		
Drawn by	LDB		


Demolition Plan

For Planning Approval

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LINE OF SIGHT PLAN scale 1:500



LINE OF SIGHT SECTION scale 1:200

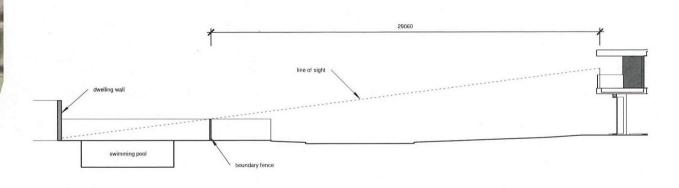



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1	Vo.	Description	Date	Γ
F	Α	facade/layout mod.	2/09/20	
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	-			1

Two Semi-Detached Two-Storey Dwellings at 8 Hamilton St., Glenelg North for A Shtjefni

2/09/20

DBG200420-P8A					
Scale at A3	As indicated				
Drawn by	LDB				

Line Of Sight Diagram